

350-2638

Equipment Manufacturer



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PLAYWORLD SYSTEMS, INC.
1000 Buffalo Road
Lewisburg, PA
17837-9795 USA

EQUIPMENT SIZE:
36'6" x 23'3" x 18'1"
11,13M x 7,09M x 5,51M

USE ZONE:
48'8" x 37'6"
14,85M x 11,44M

AREA: **1,487 SqFt.** PERIMETER: **141'10"**
138,14 SqM. 43,23M

FALL HEIGHT:
9 Ft.
2,75M

USER CAPACITY: **72** AGE GROUP: **5-12**

ADA SCHEDULE	Total Elevated Play Activities: 13		
	Accessible Elevated Activities	Accessible Ground-Level Activities	Accessible Ground-Level Play Types
Required	6	4	3
Provided	12	4	3


ASTM F1487-21
 CPSC #325



PROJECT NO: **350-2638** SCALE: **3/16"=1'-0"**

DRAWN BY: **M. MERTZ** Paper Size **B**
DATE: **11-NOV-25**

350-2638
CATALOG PRE-DESIGN

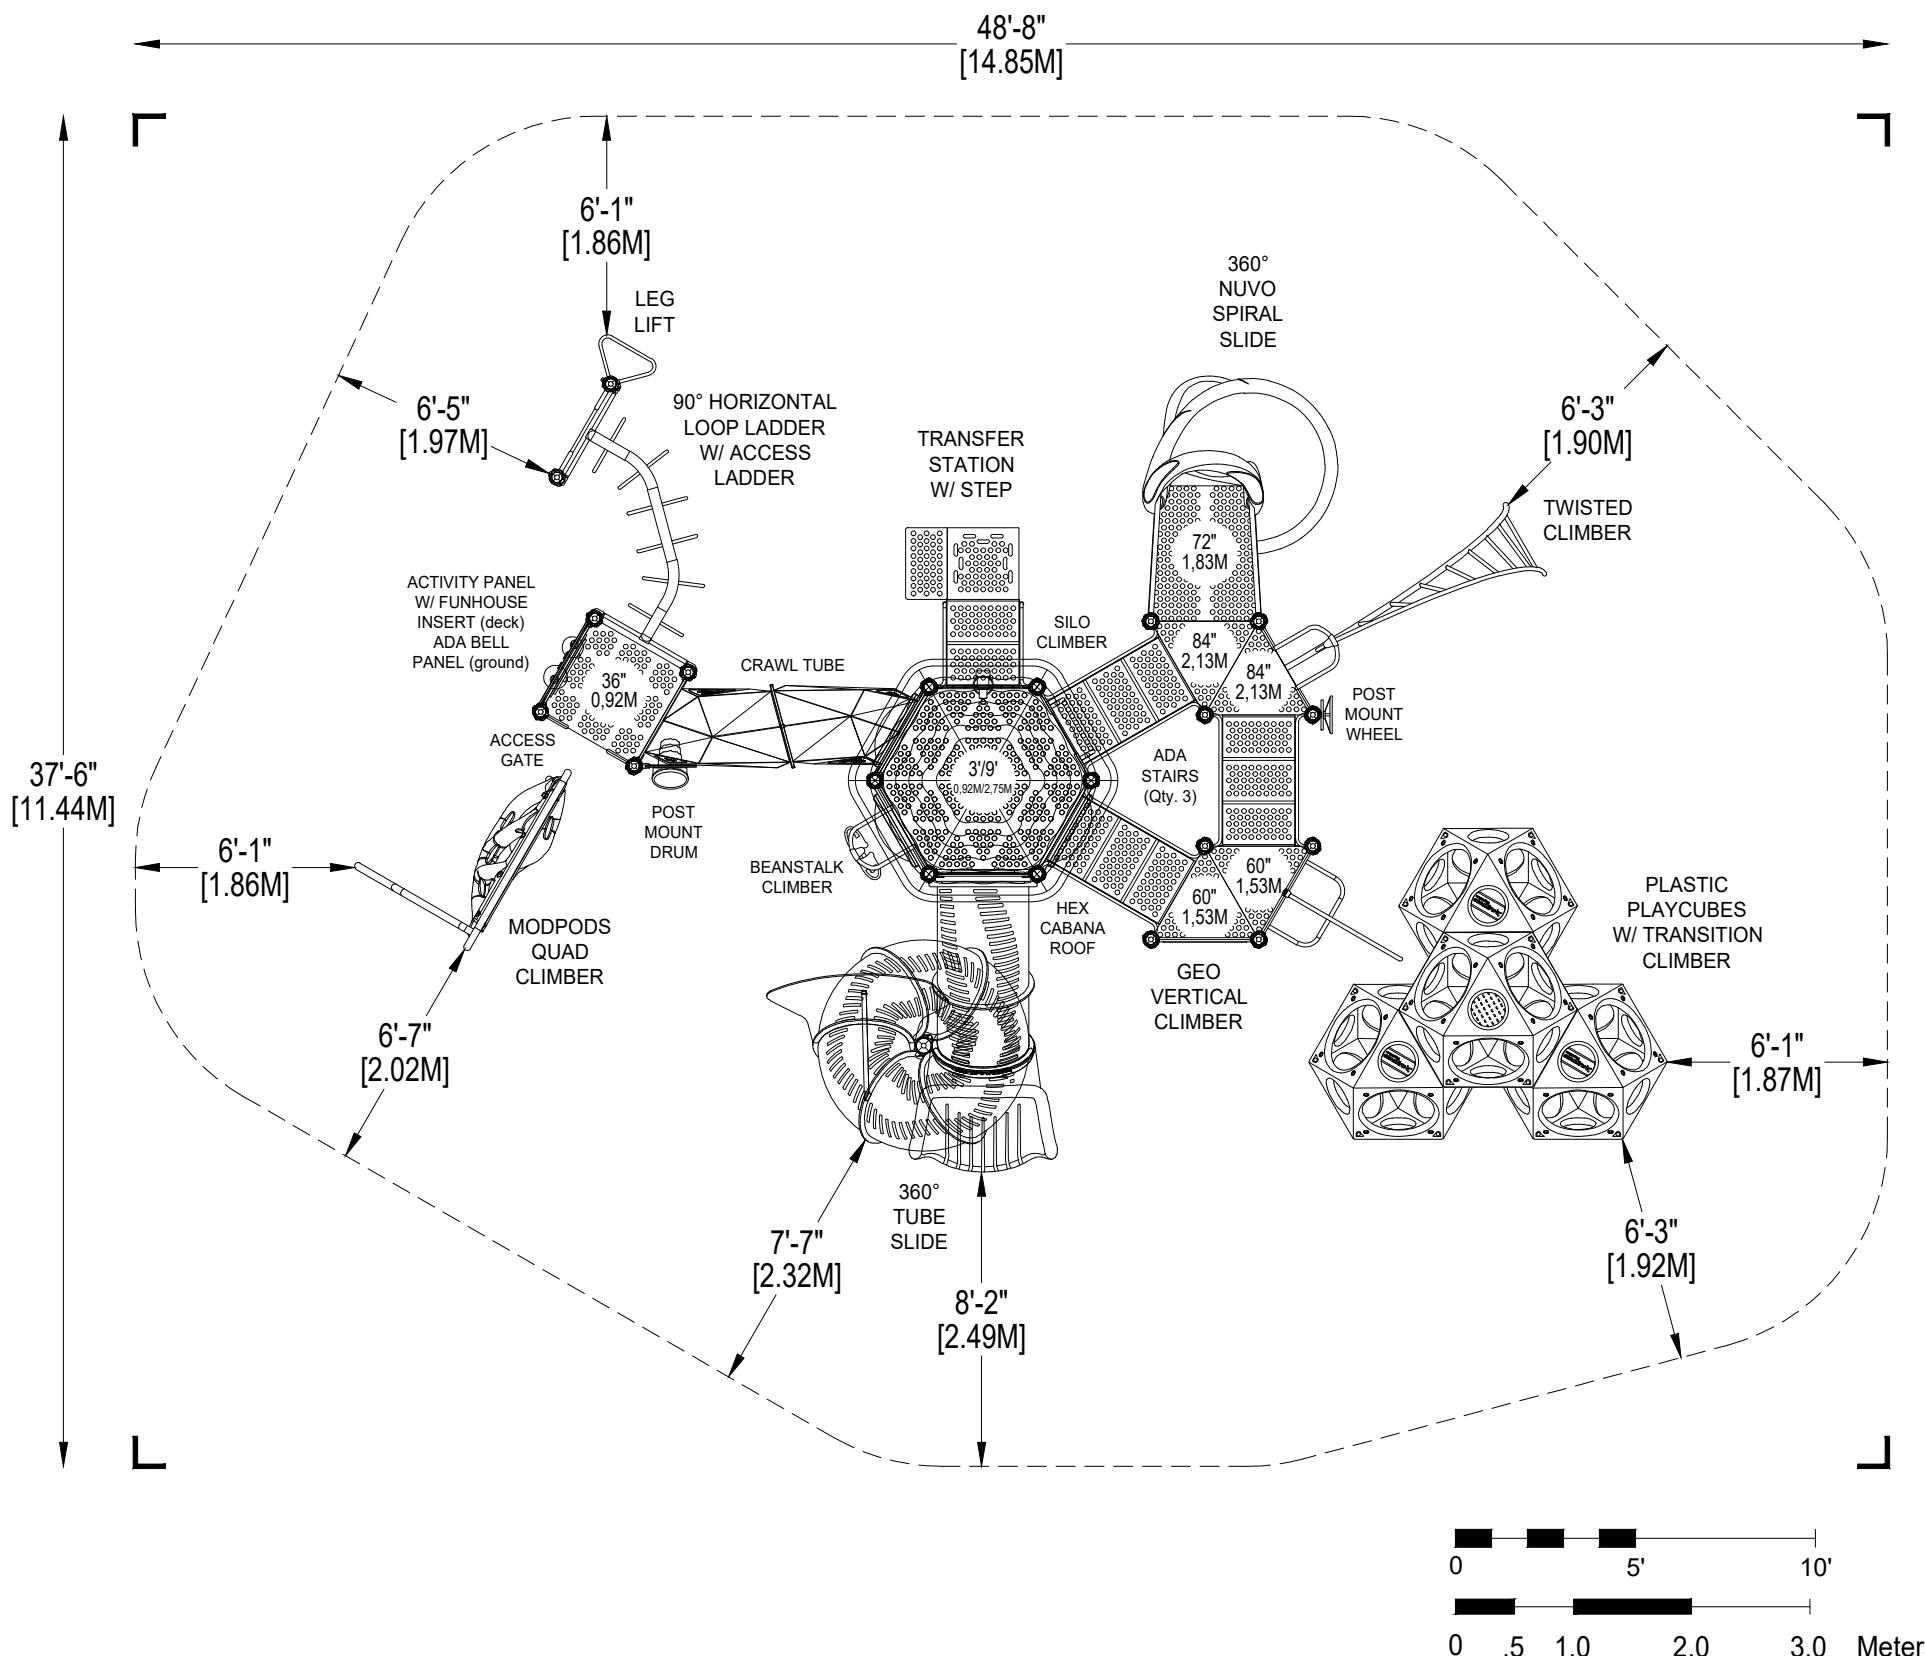

*PLAYGROUND SUPERVISION REQUIRED



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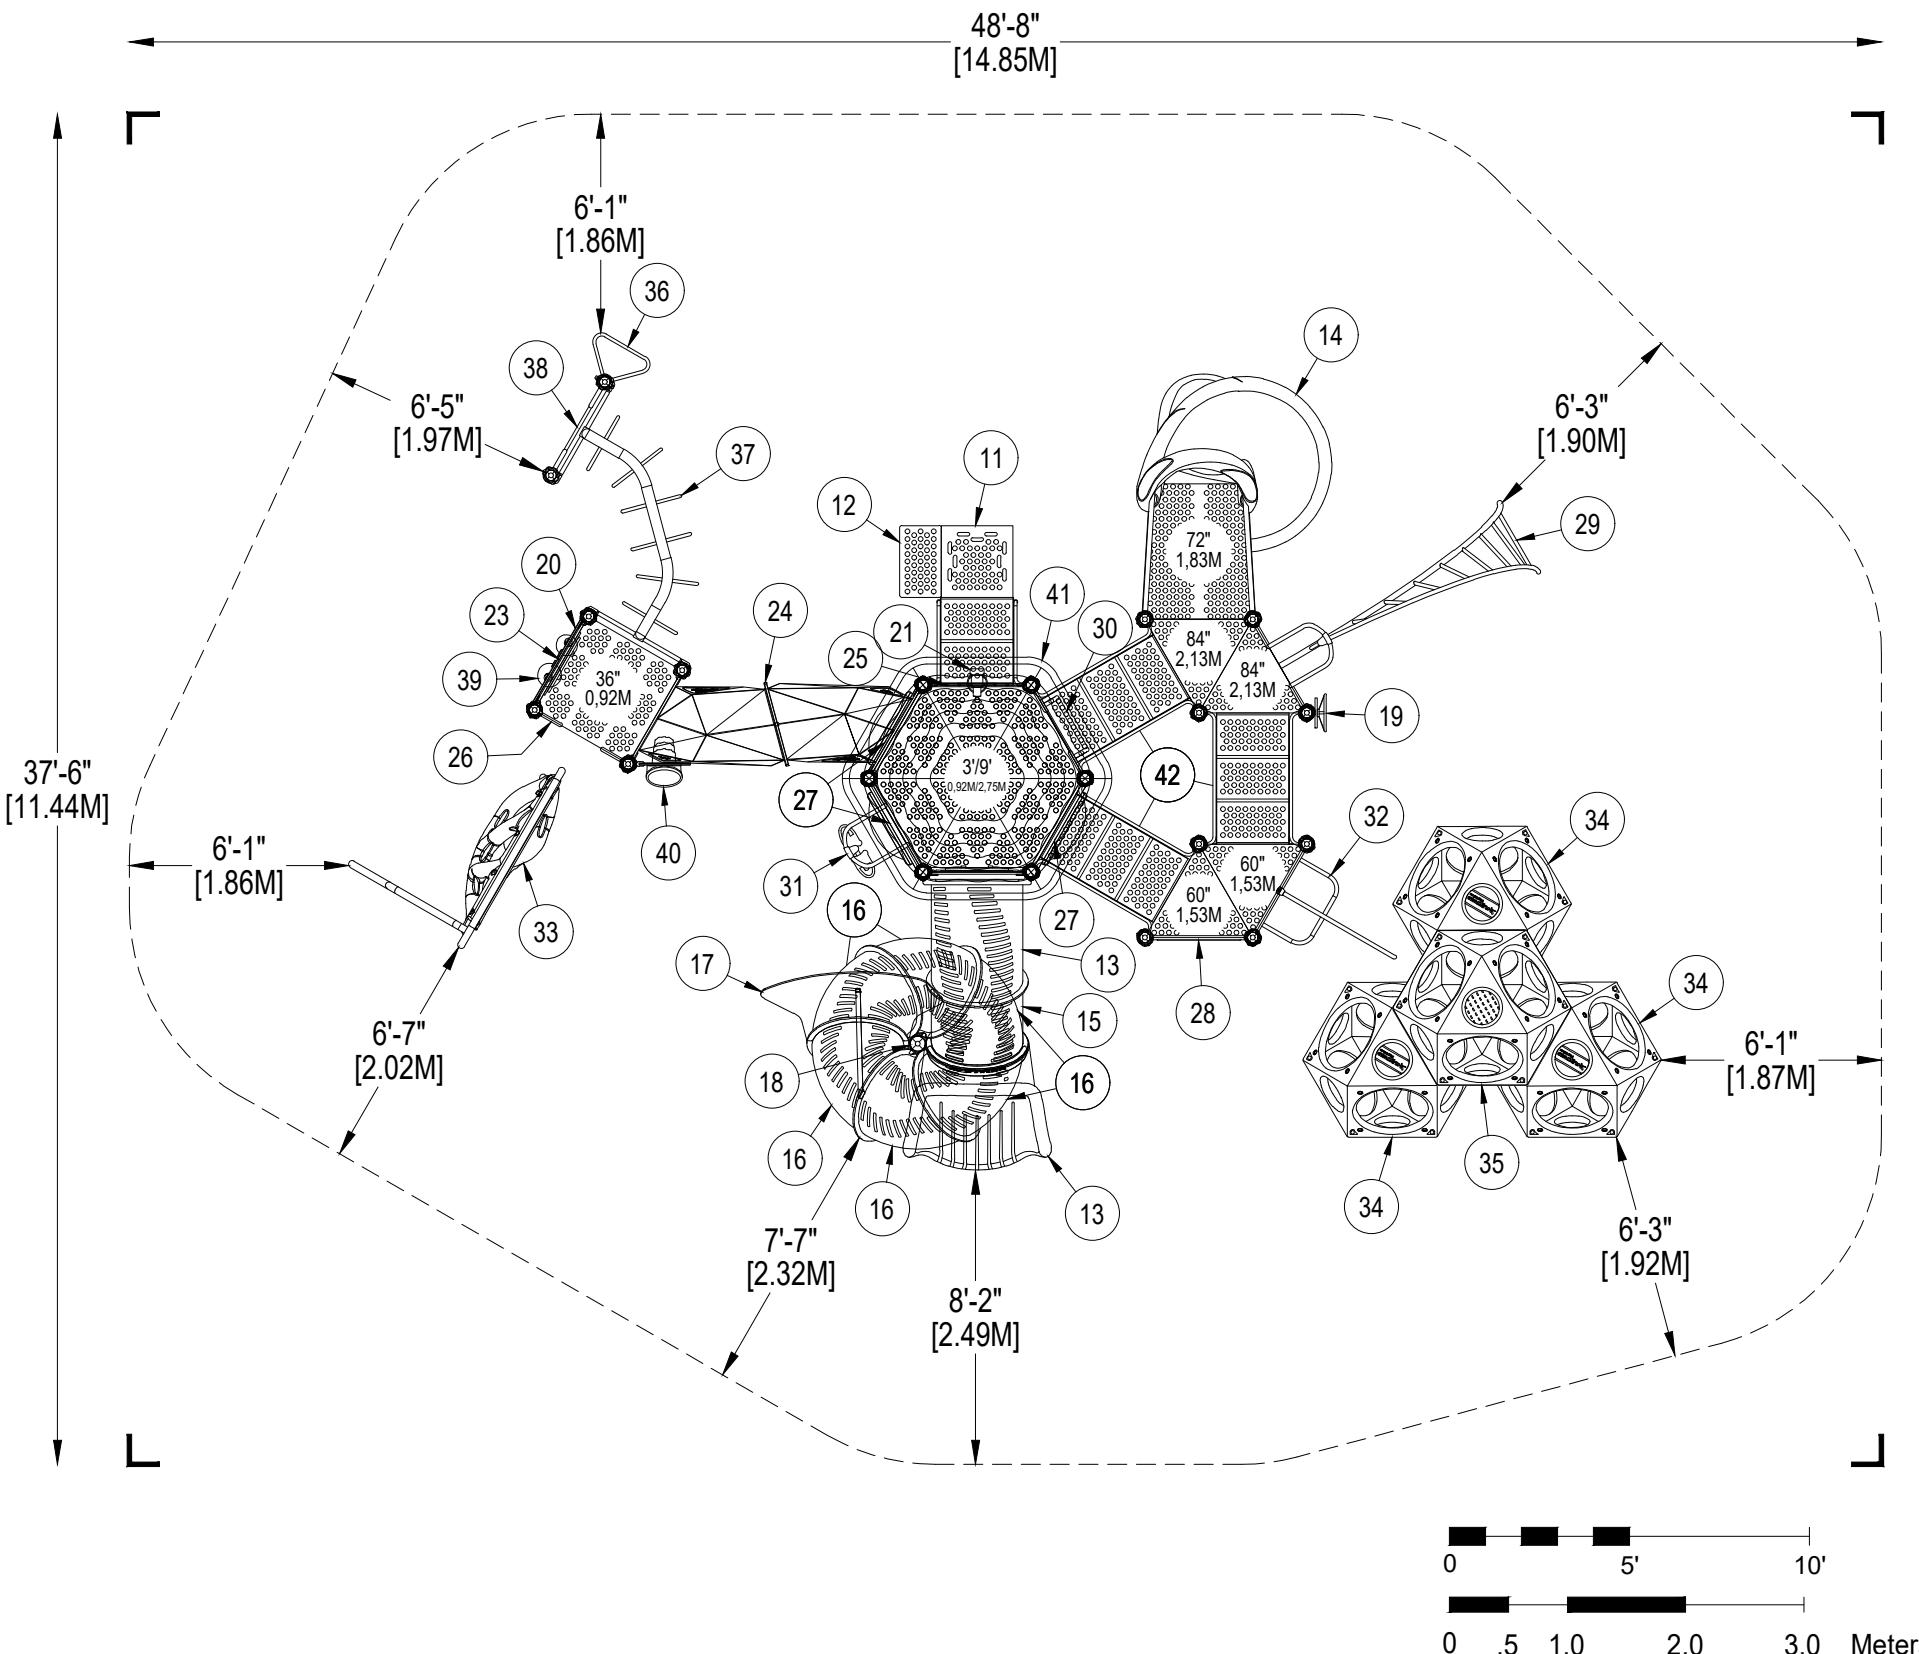
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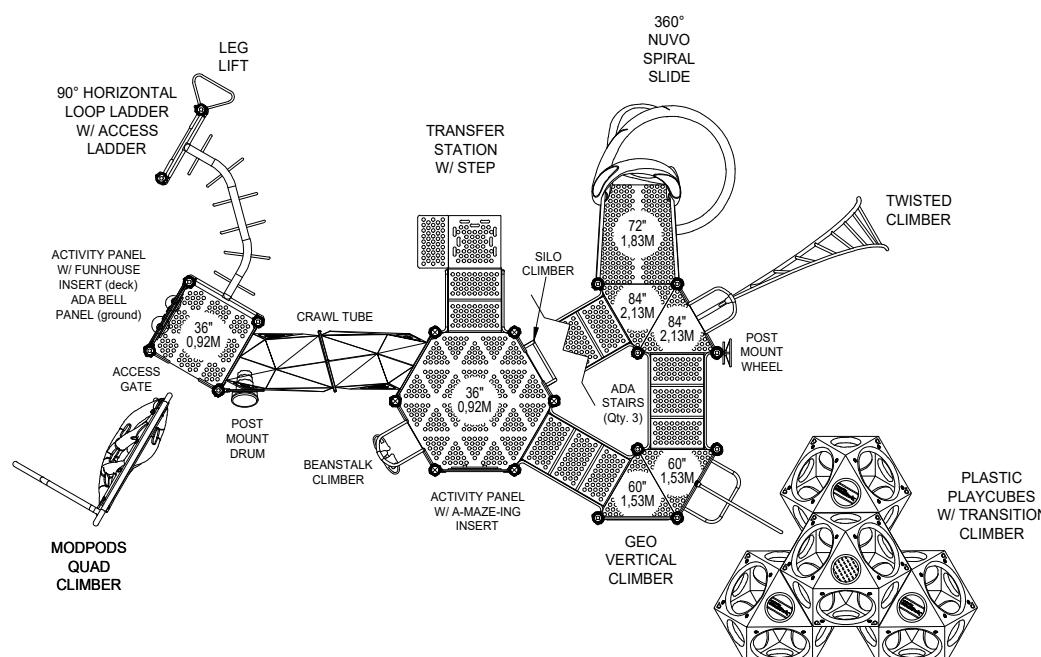
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CATALOG PRE-DESIGN




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LOWER DECK LEVELS



9' (2.75M) UPPER DECK LEVEL

NOTES:

- 1) This tower detail is a diagram of the individual level layouts of the tower portion of your play structure, showing the detailed component layout of each level.
- 2) This tower detail is not to scale and is meant for reference purposes only. It should not be used in obtaining accurate measurements for any of the equipment shown unless otherwise noted on the drawing.
- 3) This design configuration is the property of this firm and Playworld Systems® and may not be reproduced or used in any manner without the expressed written consent of this firm and Playworld Systems®.

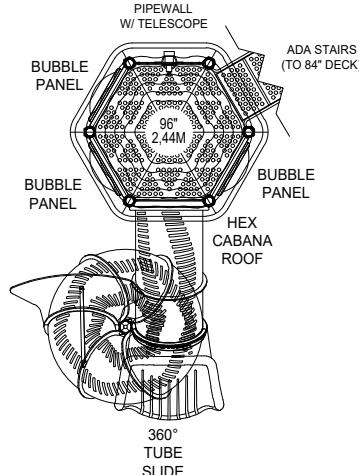350-2638


CITY, STATE

TOWER DETAIL:
Detail 1


PROJECT NO: 350-2638	SCALE: NOT TO SCALE
DRAWN BY: M. MERTZ	Paper Size B
DATE: 11-NOV-25	

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LOWER DECK LEVELS

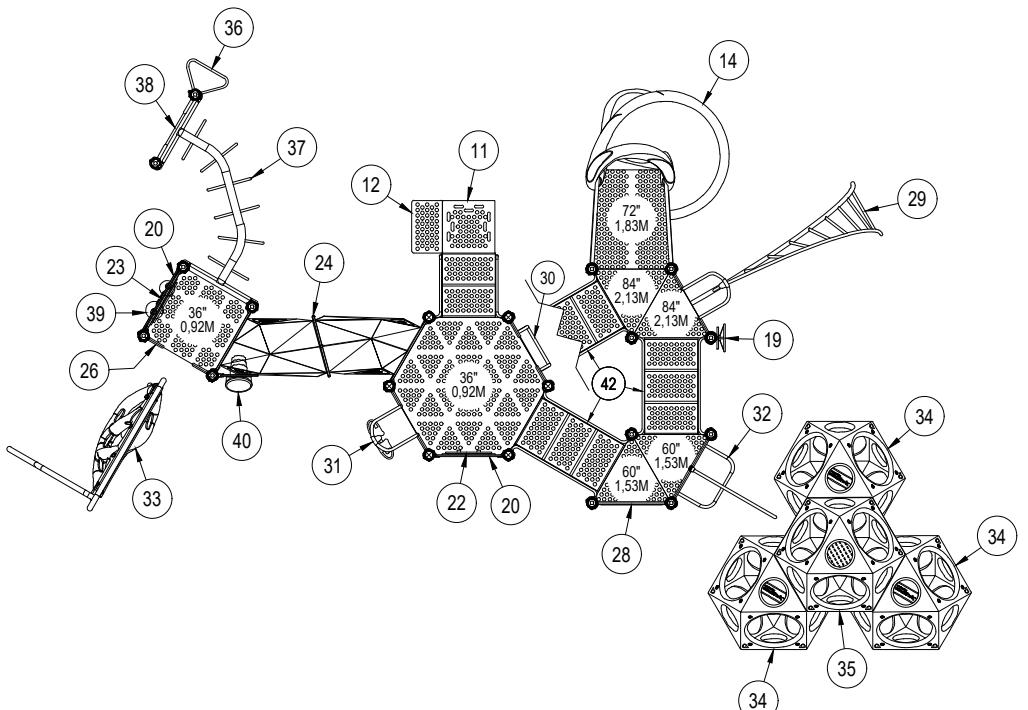


9' (2.75M) UPPER DECK LEVEL

TOWER DETAIL:
Detail 1

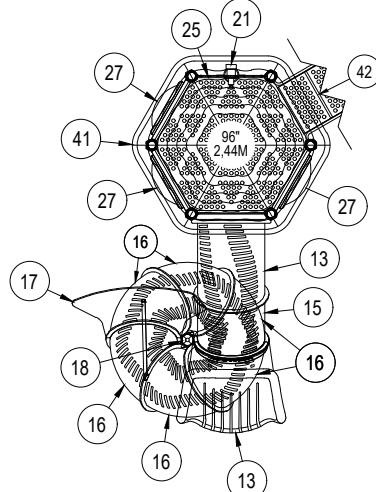PROJECT NO: 350-2638	SCALE: NOT TO SCALE
DRAWN BY: M. MERTZ	Paper Size B
DATE: 11-NOV-25	


DETAIL 1

Support Post, Spiral Slide and Post Footing Detail

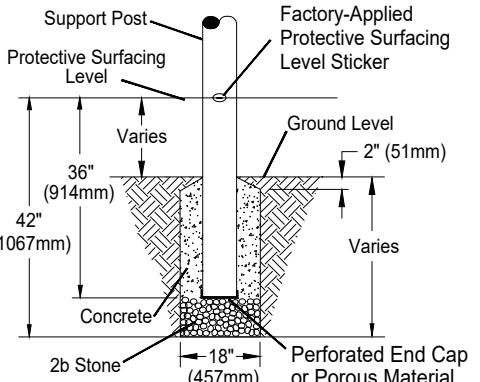

STONE OPTION

OR

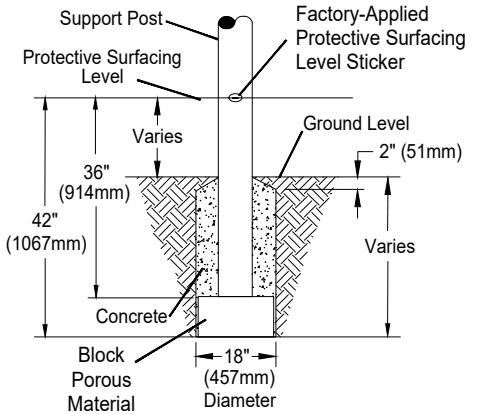


BLOCK OPTION


When utilizing Post Extensions adjust depth of footing/concrete accordingly.

DETAIL 2

GroundZero, Cantilever and "T" Post Footing Detail

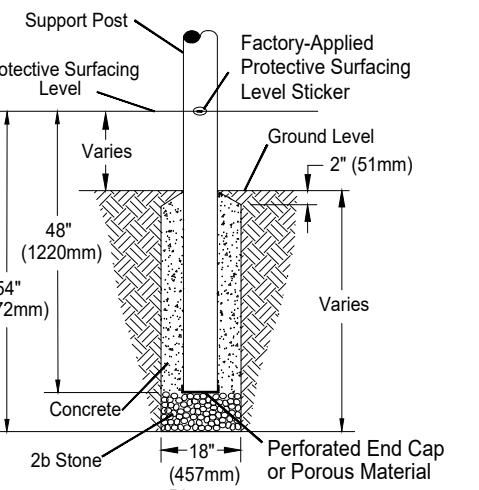


STONE OPTION

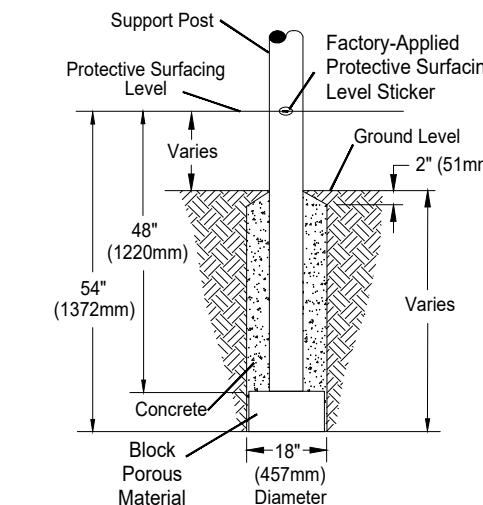

BLOCK OPTION


DETAIL 3

Component Footing Detail

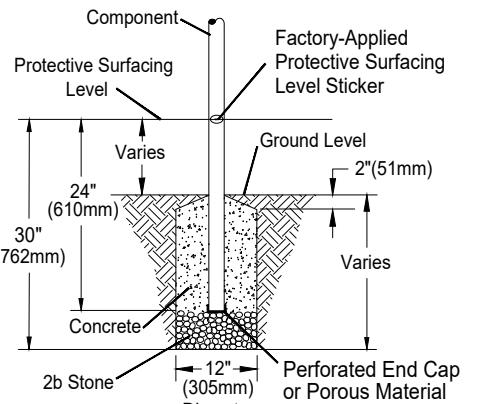

STONE OPTION


OR

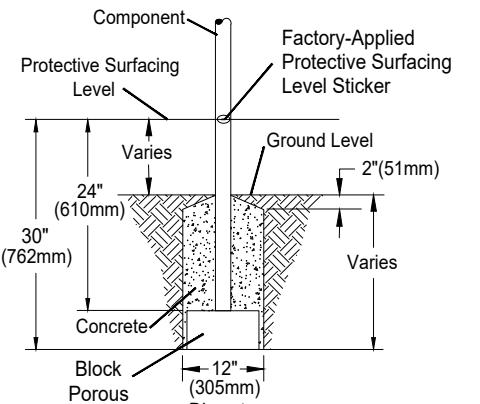

BLOCK OPTION


DETAIL 4

Surface Mount Detail

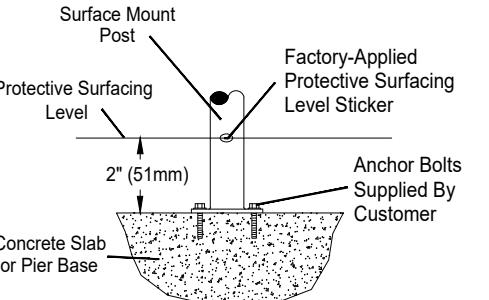

DETAIL 5

Shade Post Footing Detail

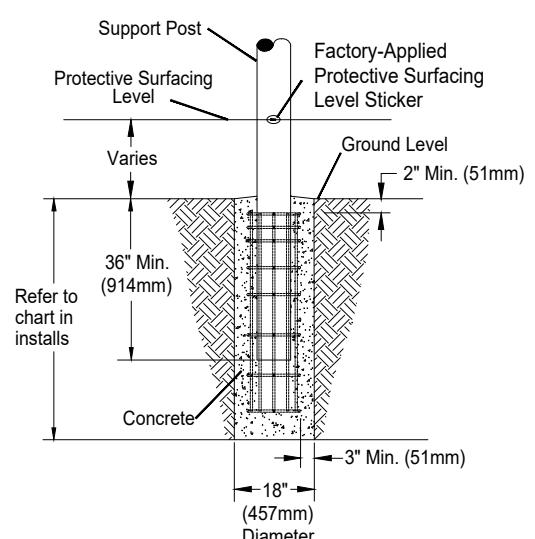

SITE NOTES:


- 1) The site plan provided must be checked against the actual site area to ensure that placement of your structure meets required clearances.
- 2) The dimensions labeled are for location of footing holes, not exact placement of equipment. Assemble, plumb, and level equipment before pouring concrete.
- 3) There must be a minimum distance of 6' (1830mm) between any obstacle, sidewalk, etc., and your structure.
- 4) Slides must have a use zone that extends out from the lower exit section of the slide a distance that is at least 6' (1830mm) or equal to the vertical distance from the highest point of the sliding surface to the top of the protective surfacing, whichever is greater. The slide use zone should not extend greater than 8' (2438mm) from the end of the lower exit section.
- 5) The complete area, including the space under and around the equipment, must be covered with an impact attenuating material. See the 1997 publication, "Handbook for Public Playground Safety", published by the U.S. Consumer Product Safety Commission, for guidelines and recommendations on the type and depth of surfacing material. For a copy of the "Handbook for Public Playground Safety", write to: U.S. Consumer Product Safety Commission
Office of Information and Public Affairs
Washington, D.C. 20207

INSTALLATION NOTES:

- 1) Paved surfaces, such as asphalt and concrete, are not acceptable for use under your structure.
- 2) It is the consumer's responsibility to check with local utilities prior to excavating footings for any underground utility lines that may exist within the installation area.
- 3) It is the consumer's responsibility to check local soil conditions and drainage within the site area. Inquire with local contractors for appropriate recommendations.
- 4) If the structure is to be installed across uneven terrain, maintain the support post mark for protective surfacing level at the lowest grade. Adjust other footings accordingly.
- 5) The base of footings must be below frost lines.
- 6) Do not encase the bottom of support posts in concrete. Place all posts directly on packed stone.
- 7) Assemble the entire structure before pouring concrete unless specifically instructed to do so in the individual component installation instructions.
- 8) Read completely the installation instructions provided with your structure prior to beginning construction.

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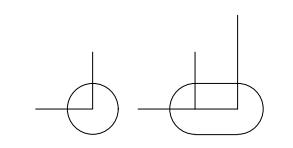
FOOTING DETAIL	SCALE: NOT TO SCALE
DRAWN BY: PW CAD	PAPER SIZE B
	DATE: 18-NOV-20

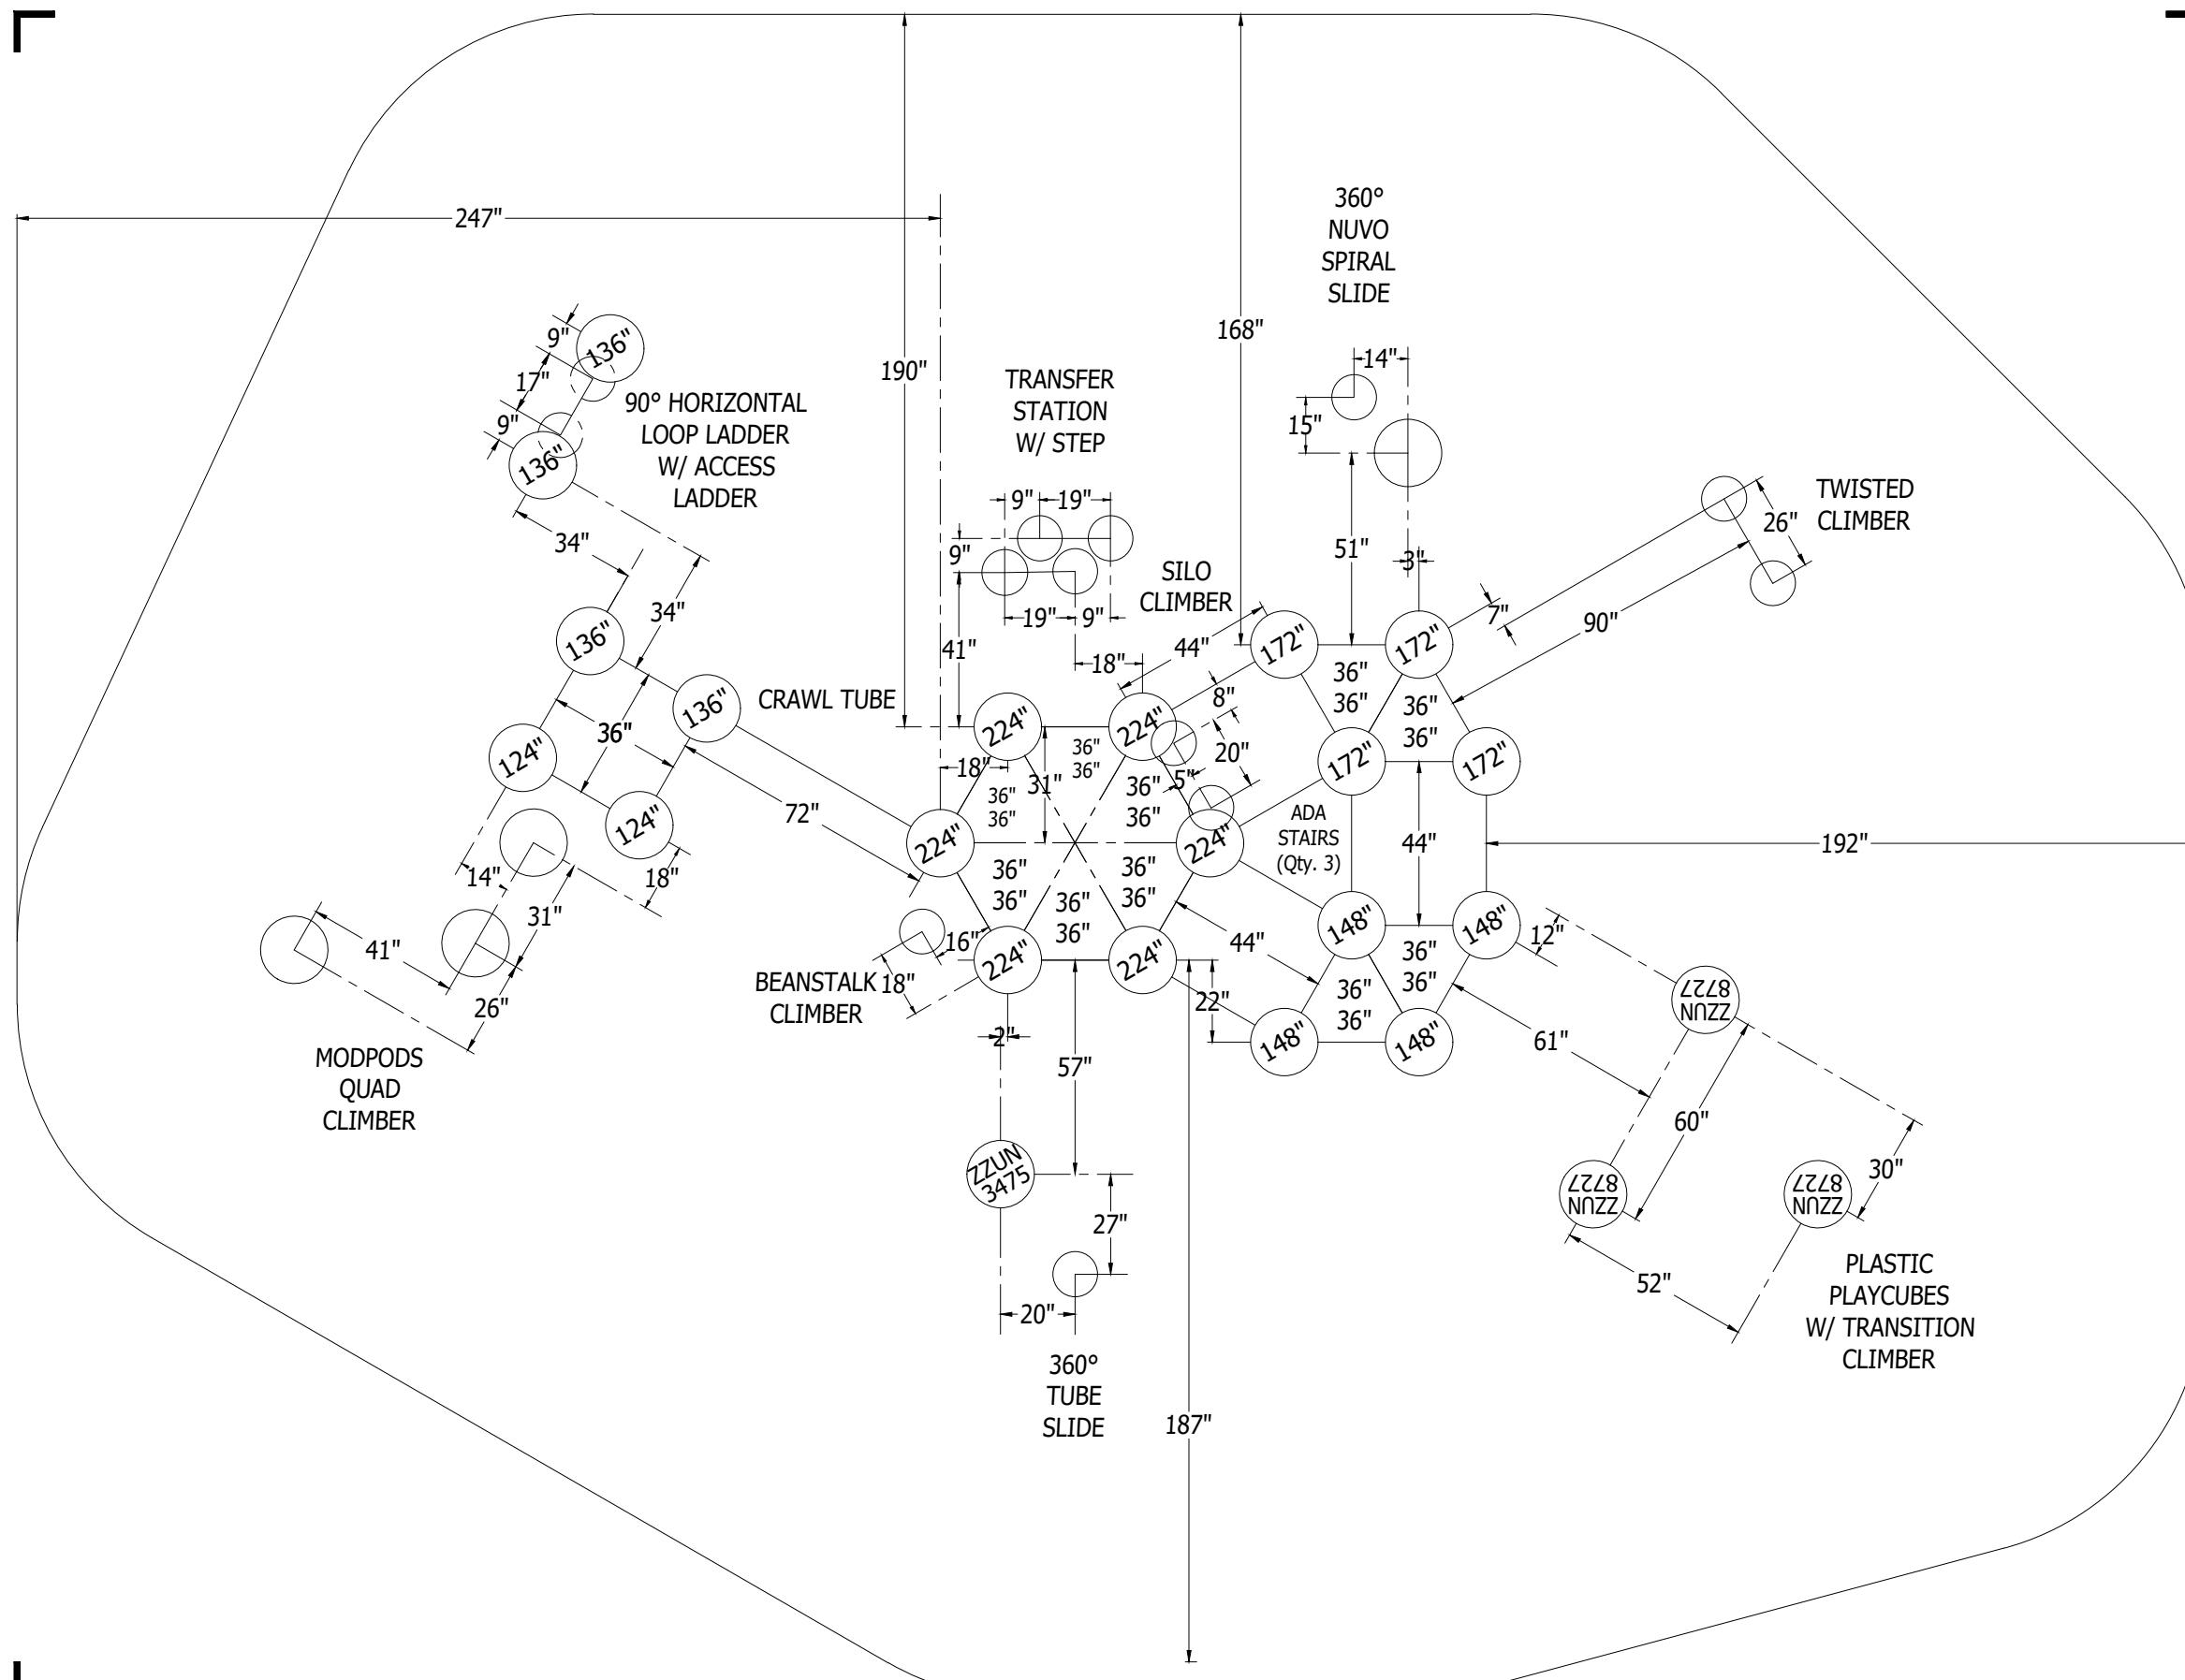


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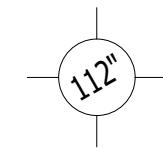
FOOTING LEGEND



COMPONENT FOOTING (DETAIL 3)




SPIRAL SLIDE CENTER POST FOOTING (DETAIL1)

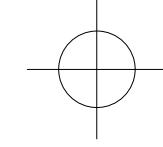

SUPPORT POST FOOTING (DETAIL 1 or 4)
(112" INDICATES POST LENGTH)



CANTILEVER, "T" POST, AND COMPONENT
POST FOOTING (DETAIL 2)
(ZZCH1850 INDICATES PART NUMBER)

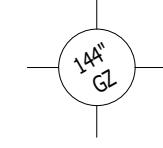

GROUND ZERO POST FOOTING (DETAIL 2)
(144" INDICATES POST LENGTH)

PROJECT NO:	SCALE:
350-2638	1/4"=1'-0"
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M. MERTZ	
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